


LEGAL DESCRIPTION

LOT_____8

SECTION 19 RANGE_____1

DISTRICT QUAMICHAN

PLAN EPP87218

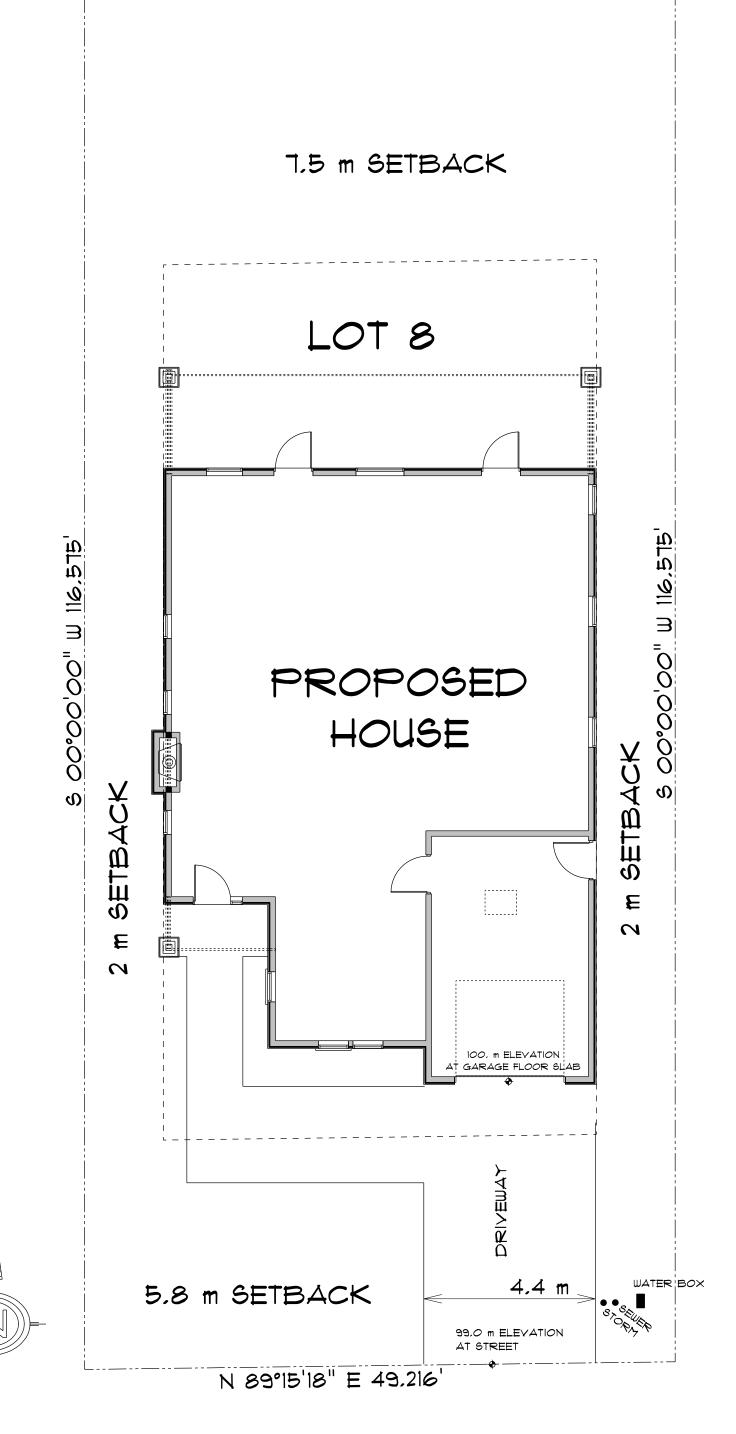

5 89°16'31" W 49.216'

SITE PLAN SCALE: 1/8" = 1'-0"

ALL DIMENSIONS TO FACE OF STUDS

 2×6 STUD WALL (5 1/2" THICK) 2×4 STUD WALL (3 1/2" THICK)

-ALL WORK SHALL CONFORM TO CURRENT BUILDING CODES AND LOCAL BYLAWS -WRITTEN DIMENSIONS TAKE PRECEDENCE OVER SCALED DRAWINGS -BUILDER MUST VERIFY ALL DIMENSIONS, INFORMATION, AND SPECIFICATIONS BEFORE STARTING WORK AND NOTIFY DESIGNER OF ANY ERRORS -FOOTINGS SHOWN ON THESE DRAWINGS HAVE BEEN DESIGNED FOR SOIL BEARING CAPACITY OF 1,500 PSF. IF LESSER BEARING CAPACITY, IT IS THE RESPONSIBILITY OF OWNER / CONTRACTOR TO HAVE FOOTINGS REDESIGNED

BY ENGINEER TO SUIT SITE CONDITIONS -ALL CONCRETE TO HAVE MINIMUM COMPRESSIVE STRENGTH OF 20mPA @ 28 DAYS -CONCRETE FOOTINGS MUST BE PLACED ON UNDISTURBED OR COMPACTED SOIL TO AN ELEVATION BELOW FROST PENETRATION

-ALL CONCRETE AND MASONARY FOUNDATION WALLS EXCEEDING LIMITS STATED IN BUILDING CODES REQUIRE DESIGN BY A REGISTERED STRUCTURAL ENGINEER -ALL FOOTINGS TO HAVE 2 ROWS OF 1/2" REBAR 3" CLEAR FROM SIDE + BOTTOM -ALL WOOD FRAMING TO BE #2 OR BETTER DOUGLAS FIR, OR SPRUCE -ALL LINTELS TO BE 2-2XIO *2 DOUGLAS FIR OR BETTER UNLESS OTHERWISE NOTED -ALL WOOD CONTACTING CONCRETE TO BE SEPARATED WITH APPROVED MATERIAL -JOISTS ARE TO BE DOUBLED UNDER PARTITIONS


-ALL ENGINEERED COMPONENTS TO BE INSTALLED TO MANUFACTURE'S SPEC. -BUILDING MUST BE PROVIDED WITH MECHANICAL VENTILATION DESIGN BY OTHER -ATTIC TO BE VENTED MINIMUM 1:300 OF AREA -UNHEATED CRAWLSPACES TO BE VENTED MINIMUM 1:500 OF AREA

VISION DESIGN PROPOSED HOUSE PLANS FOR LAKESHAW HOLDINGS DRAWN BY: JOHN YEUGER SCALE: AS SHOWN DATE: September 21, 2022 250-748-6770


MAIN FLOOR PLAN

LOT #8 1/5 OAKHILL PLACE DUNCAN, BC




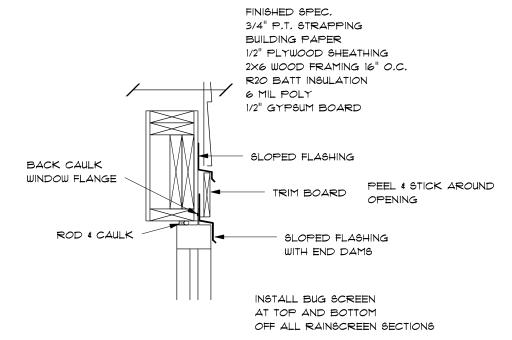


WINDOW HEAD DETAIL

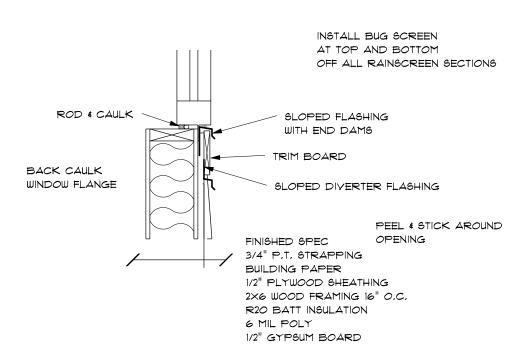


WINDOW SILL DETAIL

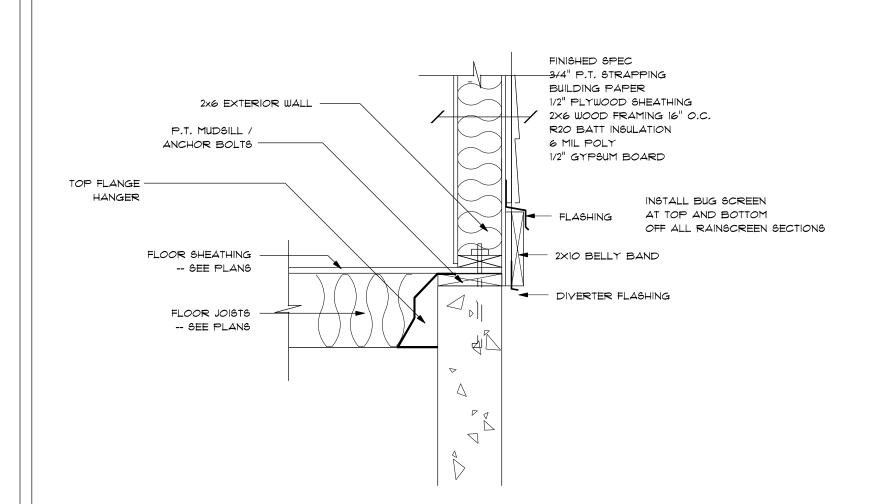

RECESSED JOIST DETAIL

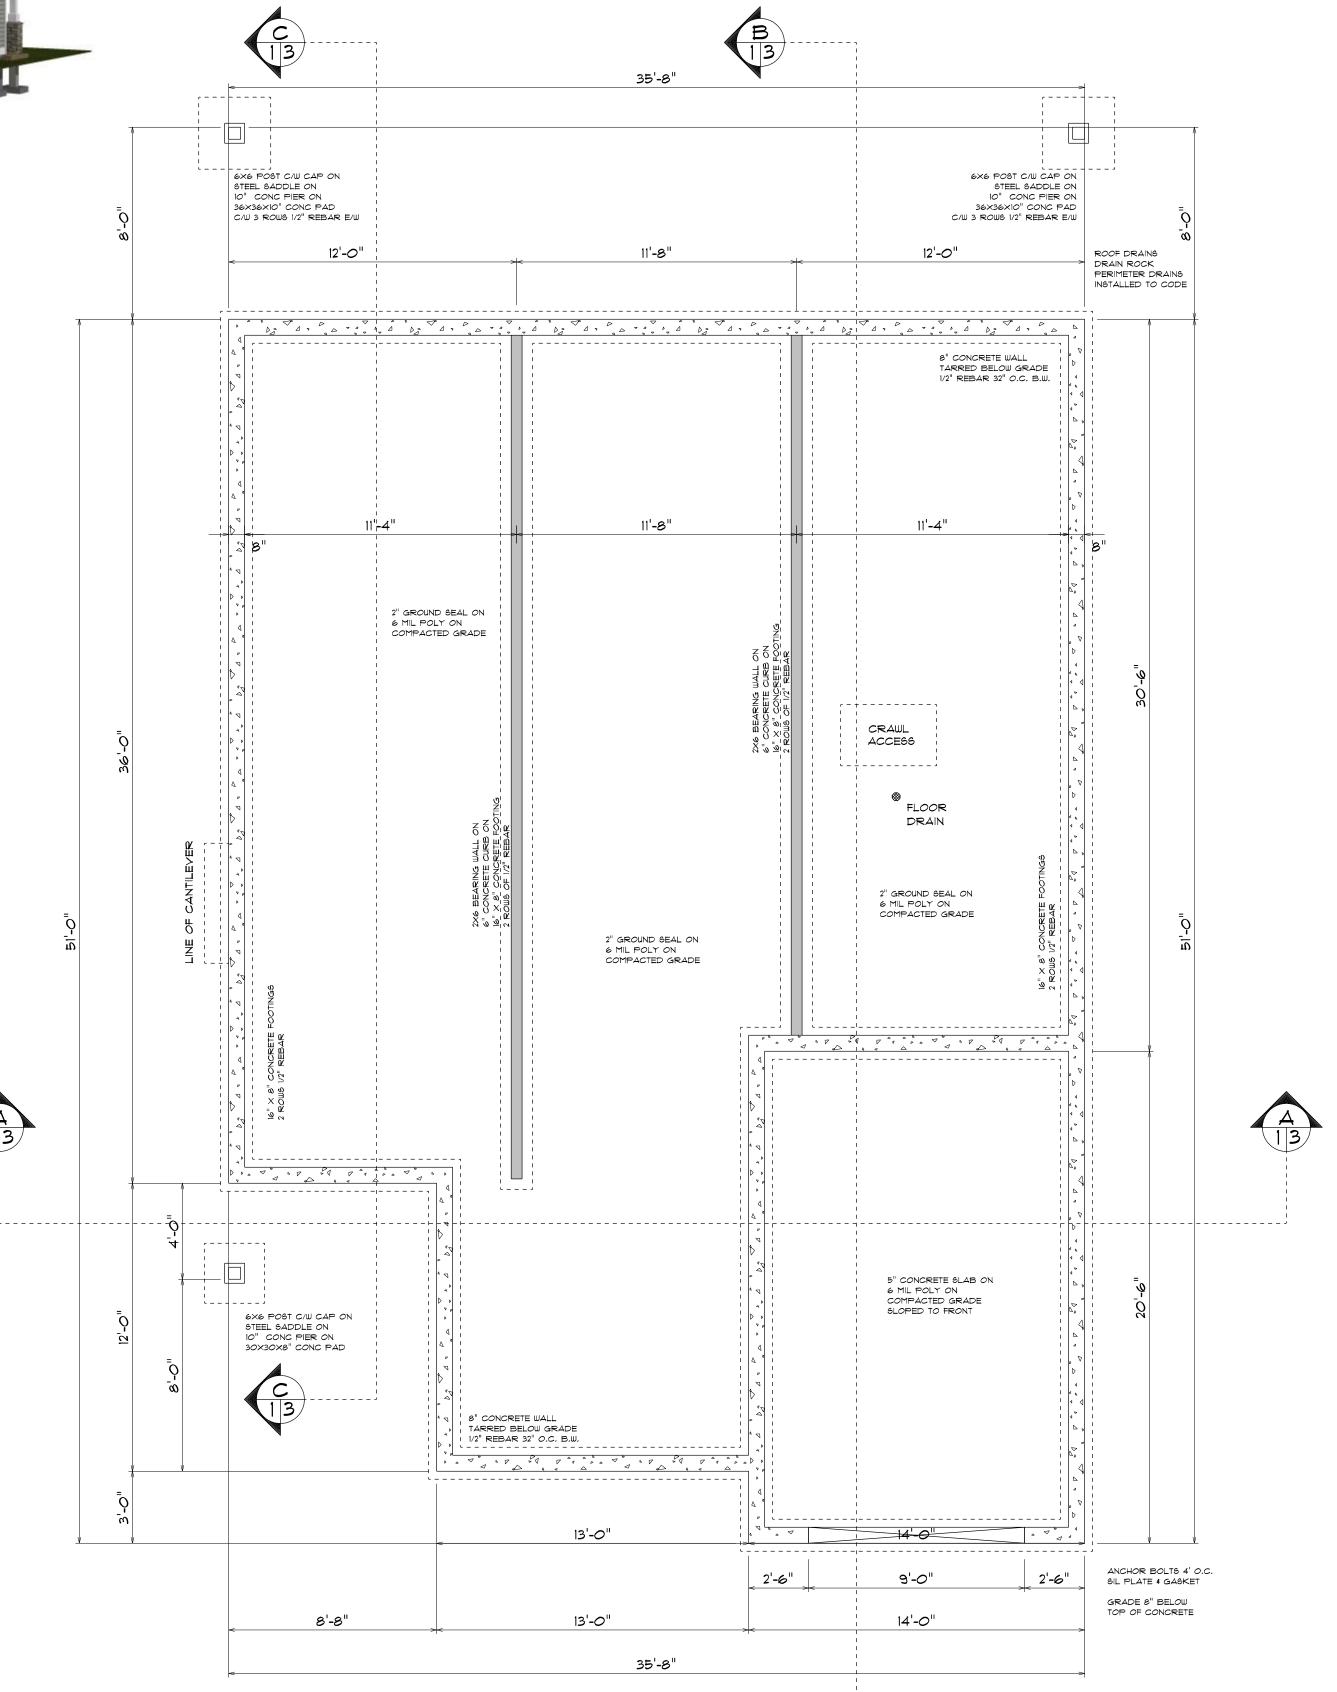

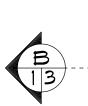


FOUNDATION PLAN

SCALE: 1/4" = 1'-0"



NOTES

2XIO FLOOR JOISTS IG" O.C. THROUGHOUT
DOUBLE JOISTS OR BLOCKING UNDER PARTITION WALLS
DOUBLE JOISTS AROUND ALL OPENINGS
USE JOIST HANGERS ON ALL UNSUPPORTED ENDS
CROSS BRIDGING @ T' MINIMUM SPAN
DOTTED LINES INDICATE CROSS BRIDGING

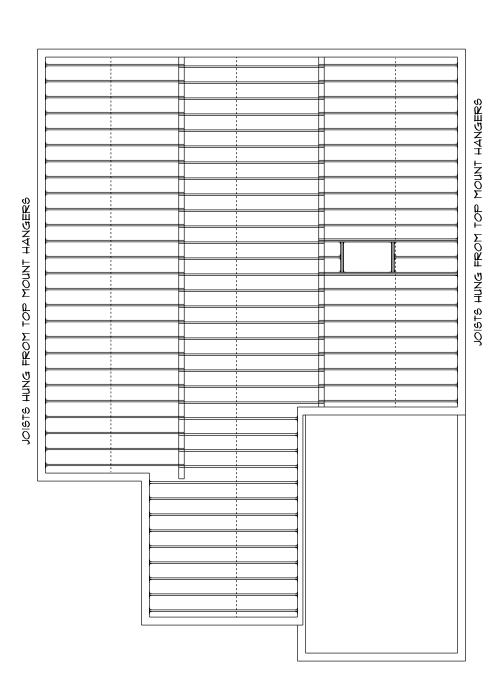

MAIN FLOOR JOIST LAYOUT

SCALE 1/8"=1'-0"



VISION DESIGN

PROPOSED HOUSE PLANS FOR LAKESHAW HOLDINGS

DRAWN BY: JOHN YEUGER

DATE: September 21, 2022

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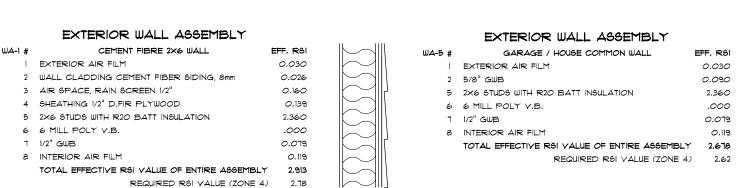
250-748-6770

FOUNDATION PLAN


LOT *8
OAKHILL PLACE
DUNCAN, BC


2/5


ZONE 4 ENERGY EFFICIENCY REQUIREMENTS




JA-7 #	8" CONCRETE / 2 1/2" STYROFOAM	EFF. R61
1	EXTERIOR AIR FILM	0.030
2	8" CONCRETE	0.080
3	2 1/2" STYROFOAM	2.150
٦	INTERIOR AIR FILM	0.119
	TOTAL EFFECTIVE RSI VALUE OF ENTIRE ASSEMBLY	2,379

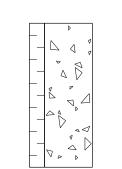

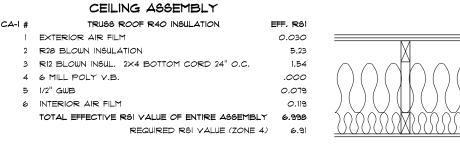

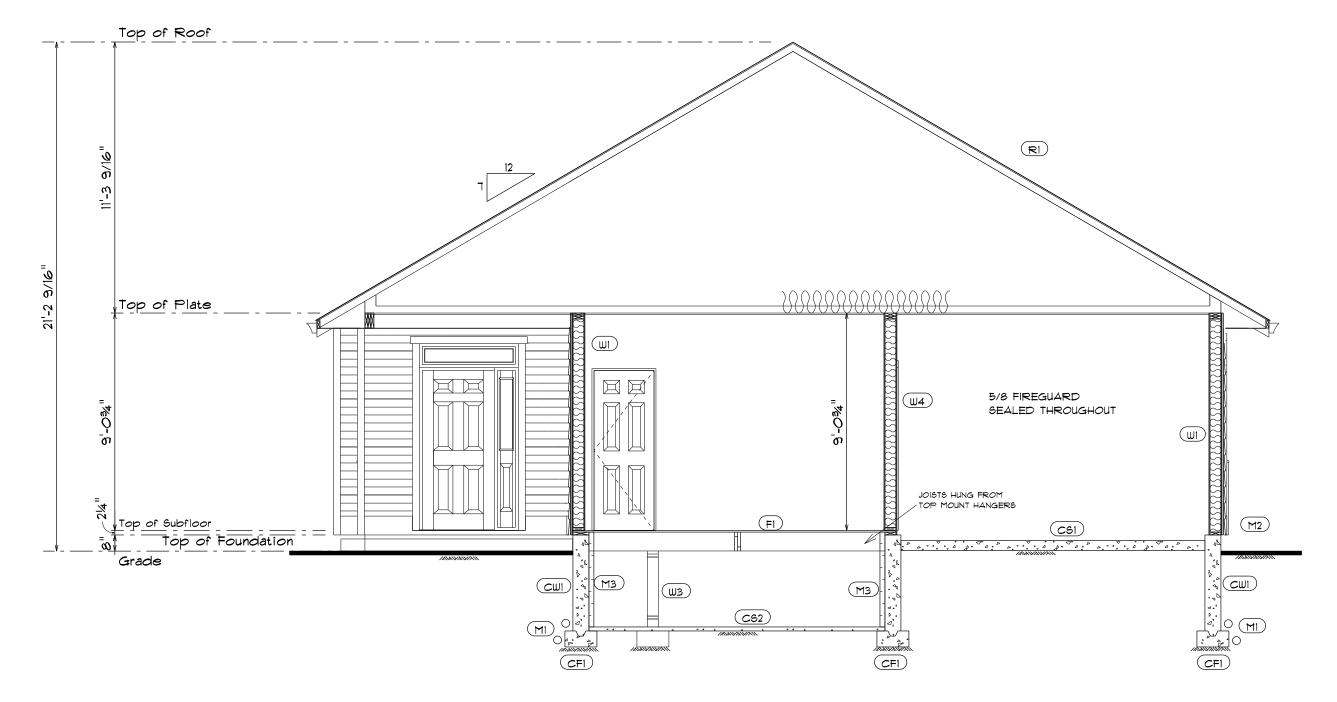

CROSS SECTION A-A SCALE: 1/4" = 1'-0"

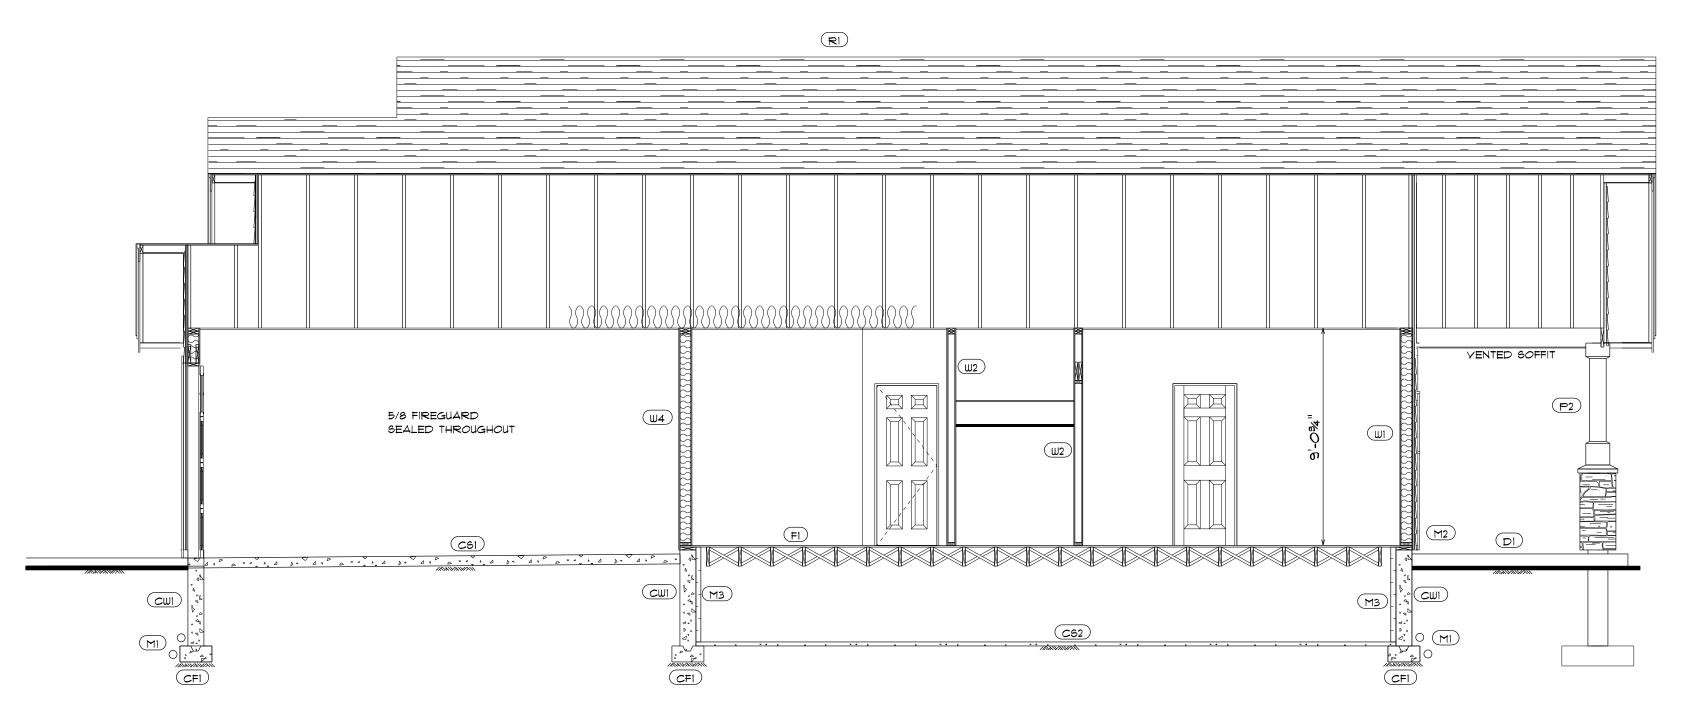

CROSS SECTION B-B SCALE: 1/4" = 1'-0"

FINISHED FLOORING

2X10 FLOOR JOISTS 16" O.C.

BUILT OUT 6X6 POST C/W CAP ON

3/4" T&G PLYWOOD


CONCRETE STOOP

CONCRETE UPSTAND


STEEL SADDLE ON 10" CONC PIER ON

DOWELLED INTO

WITH 1/2" REBAR

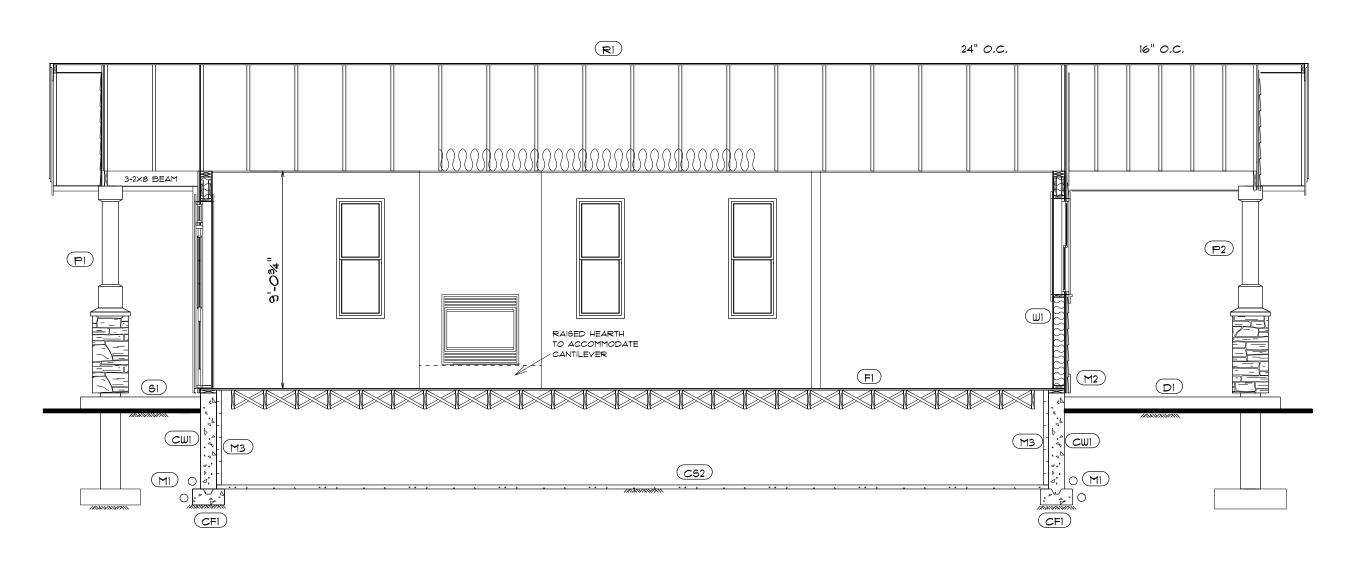

CROSS SECTION C-C SCALE: 1/4" = 1'-0"

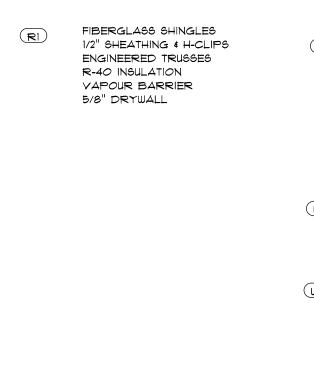

wi)	FINISHED SPEC. APPROVED RAIN SCREEN BUILDING PAPER 1/2" SHEATHING 2X6 STUDS 16" O.C. R-20 INSULATION VAPOUR BARRIER 1/2" DRYWALL
<u> </u>	1/2" DRYWALL 2×4 STUDS 16" O.C. 1/2" DRYWALL

2×6 STUDS 16" O.C.


VAPOUR BARRIER 1/2" DRYWALL

R20 BATT INSULATION

		30×30×8" CONC PAD
2X6 BEARING WALL ON 6" CONCRETE CURB ON 16" X 8" CONCRETE FOOTING 2 ROWS OF 1/2" REBAR	(P2)	BUILT OUT 6X6 POST C/W CAP ON STEEL SADDLE ON 10" CONC PIER ON 36X36X10" CONC PAD C/W 3 ROWS 1/2" REBAR E/W
5/8" FIREGUARD		CONCRETE BATIO

DI	CONCRETE PATIO DOWELLED INTO CONCRETE UPSTAND
	WITH 1/2" REBAR

CMI	8" CONCRETE WALL TARRED BELOW GRADE 1/2" REBAR 32" O.C. B.W.

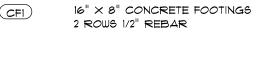



2" GROUND SEAL ON
6 MIL POLY ON
COMPACTED GRAD



ANCHOR BOLTS 4' O.C.
SIL PLATE & GASKET

GRADE 8" BELOW
TOP OF CONCRETE

M3 2.5" R-12 RIDGID INSULATION




PROPOSED HOUSE PLANS FOR LAKESHAW HOLDINGS

SCALE:	AS SHOWN	DRAWN BY:	JOHN YEUGER
DATE:	September 21, 2022	PHONE:	250-748-6770

CROSS SECTIONS

OAKHILL PLACE DUNCAN, BC 3/5

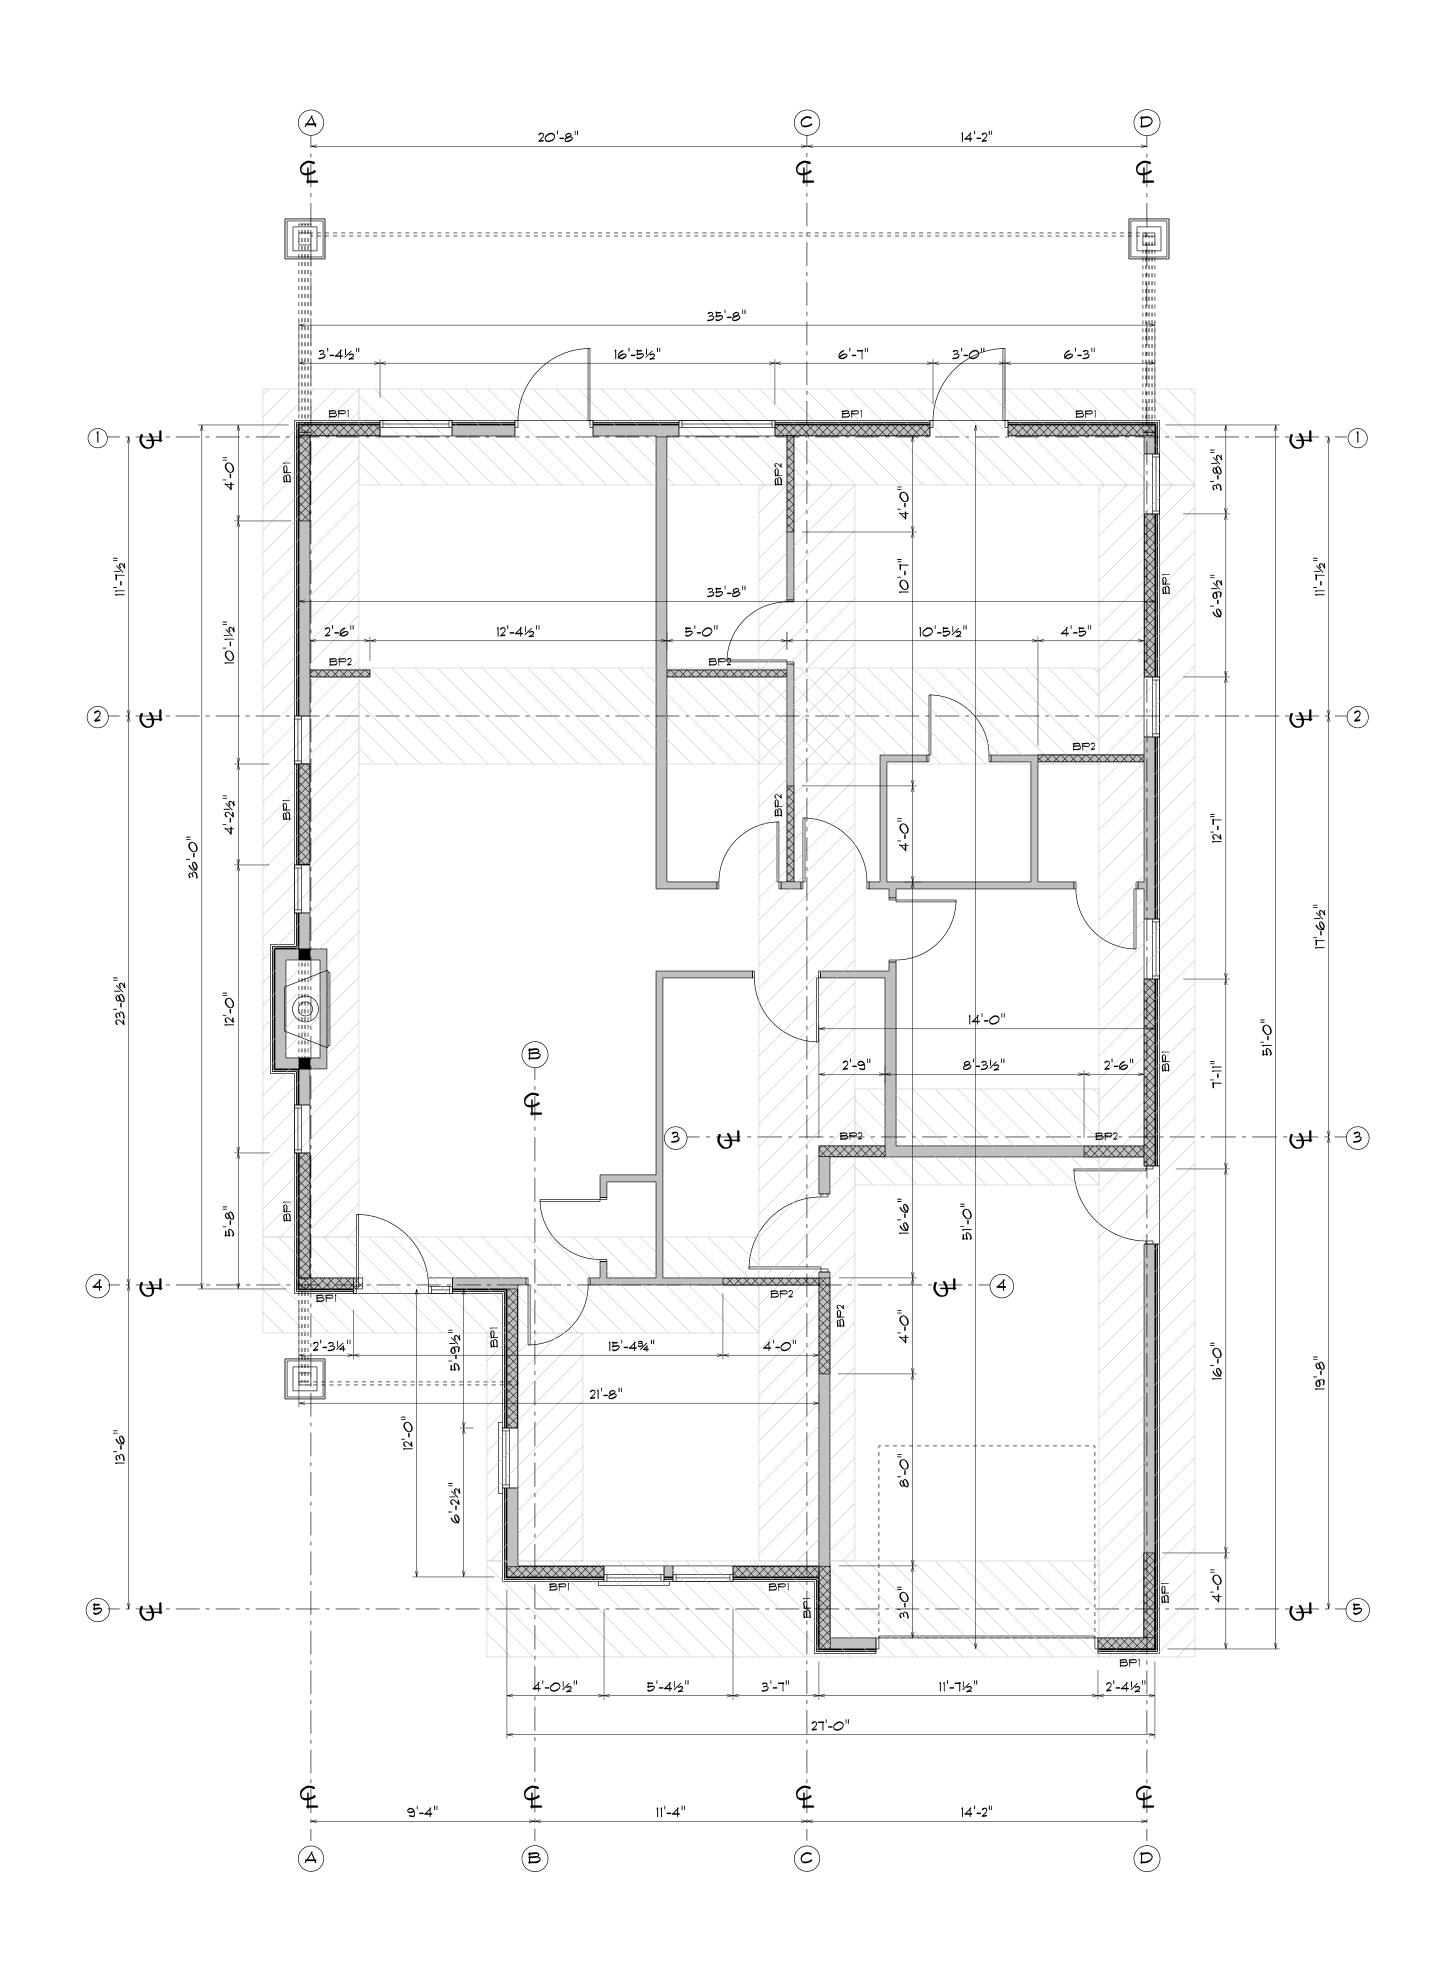

MAIN FLOOR PLAN

SEISMIC REGION 1.1 (Sa(0.2) (1.2

WALL BAND #	FLOOR	LENGTH OF WALL	LENGTH OF BRACED PANEL	%
1	MAIN	35'-8"	16'-2"	45%
2	MAIN	35'-8"	11'-11"	33%
3	MAIN	14'-0"	5'-3"	37%
4	MAIN	21'-8"	4'-0"	28%
5	MAIN	27'-0"	9'-11"	36%
Д	MAIN	36'-0"	13'-10"	38%
B	MAIN	12'-0"	5'-9"	47%
С	MAIN	51'-0"	15'-0"	29%
D	MAIN	51'-0"	18'-8"	36%

DISTANCE BETWEEN WALL BANDS = 24'-11" (IF INTERIOR WALL IS SHEETED WITH PLYWOOD) = 34'-9" DISTANCE BETWEEN BRACED WALL PANEL EDGES = 20'-11" (IF ALL BRACED PANELS ARE 4' OR MORE) = 23'-11" DISTANCE FROM CORNER TO EDGE OF PANEL = 1'-10"

BPI

BRACED WALL PANEL 1/2" PLYWOOD SHEATHING ONE SIDE NAILED TO CODE 2 1/2" NAILS 3" @ EDGE 12" @ FIELD 1/2" ANCHOR BOLTS 4' O.C. MIN 2 PER PANEL MAX 1'-8" FROM END

BRACED WALL PANEL 1/2" PLYWOOD SHEATHING ONE SIDE OR DRYWALL BOTH SIDES

NAILED OR SCREWED TO CODE 1/2" ANCHOR BOLTS 4' O.C. MIN 2 PER PANEL MAX 1'-8" FROM END

BP3

BRACED WALL PANEL 1/2" PLYWOOD SHEATHING ONE SIDE

AND DRYWALL BOTH SIDES

NAILED OR SCREWED TO CODE 1/2" ANCHOR BOLTS 4' O.C. MIN 2 PER PANEL MAX 1'-8" FROM END

BRACED WALL BAND DESIGNATION

CENTER LINE

BRACED WALL BAND

FRONT OF GARAGE WALLS ARE EXEMPT IF THEY MEET THE FOLLOWING REQUIREMENTS

9.23.13.5.(4) THE FRONT WALL OF ATTACHED GARAGES SERVING A SINGLE DWELLING UNIT NEED NOT COMPLY WITH SENTENCE (1) WHERE THESE WALLS DO NOT SUPPORT A FLOOR 9.23.13.5.(5) BRACED WALL PANELS IN THE BRACED WALL BAND AT THE FRONT OF AN ATTACHED GARAGE SERVING A SINGLE DWELLING UNIT NEED NOT COMPLY WITH SENTENCE (1), PROVIDEDE A) THE MAXIMUM SPACING BETWEEN THE FRONT OF THE GARAGE AND THE BACK WALL OF THE

GARAGE DOES NOT EXCEED 7.6M (24'-11") B) THYERE IS NOT MORE THAN ONE FLOOR ABOVE THE GARAGE

C) NOT LESS THAN 50% OF THE LENGTH OF THE BACK WALL OF THE GARAGE IS CONSTRUCTED OF BRACED WALL PANELS

D) NOT LESS THAN 25% OF THE LENGTH OF THE SIDE WALLS IS CONSTRUCTED OF BRACED WALL PANELS

REQUIREMENTS FOR BRACED WALL PANELS IN BASEMENTS OR CRAWL SPACES

9.23.13.5.(2) IN BAGEMENTS OR CRAWLS SPACES WHERE THE PERIMETER FOUNDATION WALLS EXTEND FROM THE FOOTINGS TO THE UNDERSIDE OF THE SUPPORTED FLOOR, BRACED WALL BANDS CONSTRUCTED WITH BRACED WALL PANELS SHALL BE SPACED NOT MORE THAN

A) 15M FROM THE PERIMETER FOUNDATION WALLS B) 15M FROM THE INTERIOR FOUNDATION WALLS, AND

C) 15M FROM ADJACENT BRACED WALL BANDS CONSTRUCTED WITH BRACED WALL PANELS



DATE: September 21, 2022

DUNCAN, BC

PROPOSED HOUSE PLANS FOR

250-748-6770

LAKESHAW HOLDINGS DRAWN BY: JOHN YEUGER SCALE: AS SHOWN

BRACED WALL PANEL

OAKHILL PLACE





FRONT ELEVATION

SCALE: 1/4" = 1'-0"

SCALE: 1/4" = 1'-0"





REAR ELEVATION

SCALE: 1/4" = 1'-0"

SCALE: 1/4" = 1'-0"

